

FOURTH AMENDMENT TO TOWER LEASE AGREEMENT

This Fourth Amendment to Tower Lease Agreement (the “Amendment”) is made and entered into this 6th day of June, 2024 (the “Fourth Amendment Effective Date”), by and between **The Osceola County Board of County Commissioners**, a political subdivision of the State of Florida (“Landlord”), and **Cellco Partnership**, a Delaware general partnership d/b/a Verizon Wireless (“Tenant”).

RECITALS:

WHEREAS, Landlord and Tenant are party to that certain Tower Lease Agreement dated August 15, 2005, as amended by that certain First Amendment to Tower Lease Agreement dated May 24, 2016, that certain Second Amendment to Tower Lease Agreement dated September 1, 2021, and that certain Third Amendment to Tower Lease Agreement dated November 2, 2023 (collectively, the “Agreement”), pursuant to which Landlord leases to Tenant certain premises as more particularly described in the Agreement; and

WHEREAS, Landlord and Tenant desire to amend certain terms of the Agreement as provided herein.


NOW, THEREFORE, in consideration of the mutual covenants herein set forth and other good and valuable consideration, the receipt and sufficiency of which is hereby acknowledged, Landlord and Tenant hereby agree as follows:

1. Capitalized terms not defined herein shall have the same meanings ascribed to such terms in the Agreement.
2. As of the Fourth Amendment Effective Date, Landlord agrees that Tenant shall be permitted to make the equipment modifications depicted in Exhibit B-4 attached hereto and incorporated herein by reference.
3. Exhibit B-3 to the Agreement is hereby deleted in its entirety and replaced with Exhibit B-4 attached hereto. Exhibit B-4 to this Amendment hereby supplements Exhibit B-2 to the Agreement. As of the Fourth Amendment Effective Date, any references to Exhibit B will be deemed to refer collectively to Exhibit B-2 to the Agreement and Exhibit B-4 to this Amendment. In the event of any inconsistency between Exhibit B-2 attached to the Agreement and Exhibit B-4 attached hereto, the latter shall control.
4. The parties hereby reaffirm their rights and obligations under the Agreement as modified by this Amendment. In the event of any inconsistencies between the Agreement and this Amendment, the terms of this Amendment shall control. The Agreement and this Amendment contain all agreements, promises or understandings between Landlord and Tenant. No verbal or oral agreements, promises or understandings shall be binding upon either Landlord or Tenant in any dispute, controversy, or proceeding at law, and any addition, variation or modification to the Agreement or this Amendment shall be void and ineffective unless made in writing and signed by the parties hereto. In the event any provision of the Agreement or this Amendment is found to be invalid or unenforceable, such a finding shall not affect the validity and enforceability of the remaining provisions of the Agreement or this Amendment.

IN WITNESS WHEREOF, the parties hereto have caused this Amendment to be executed as of the date indicated above.

Landlord:

The Osceola County Board of County Commissioners, a political subdivision of the State of Florida

By: 
Name: Don Fisher
Title: County Manager
Date: April 19, 2024

Tenant:


Cellco Partnership d/b/a Verizon Wireless

By: 
Name: Jhonathan Montenegro
Title: Associate Director - Real Estate
Date: 6/6/2024

EXHIBIT B-4

Tenant Equipment

[See attached five (5) pages.]

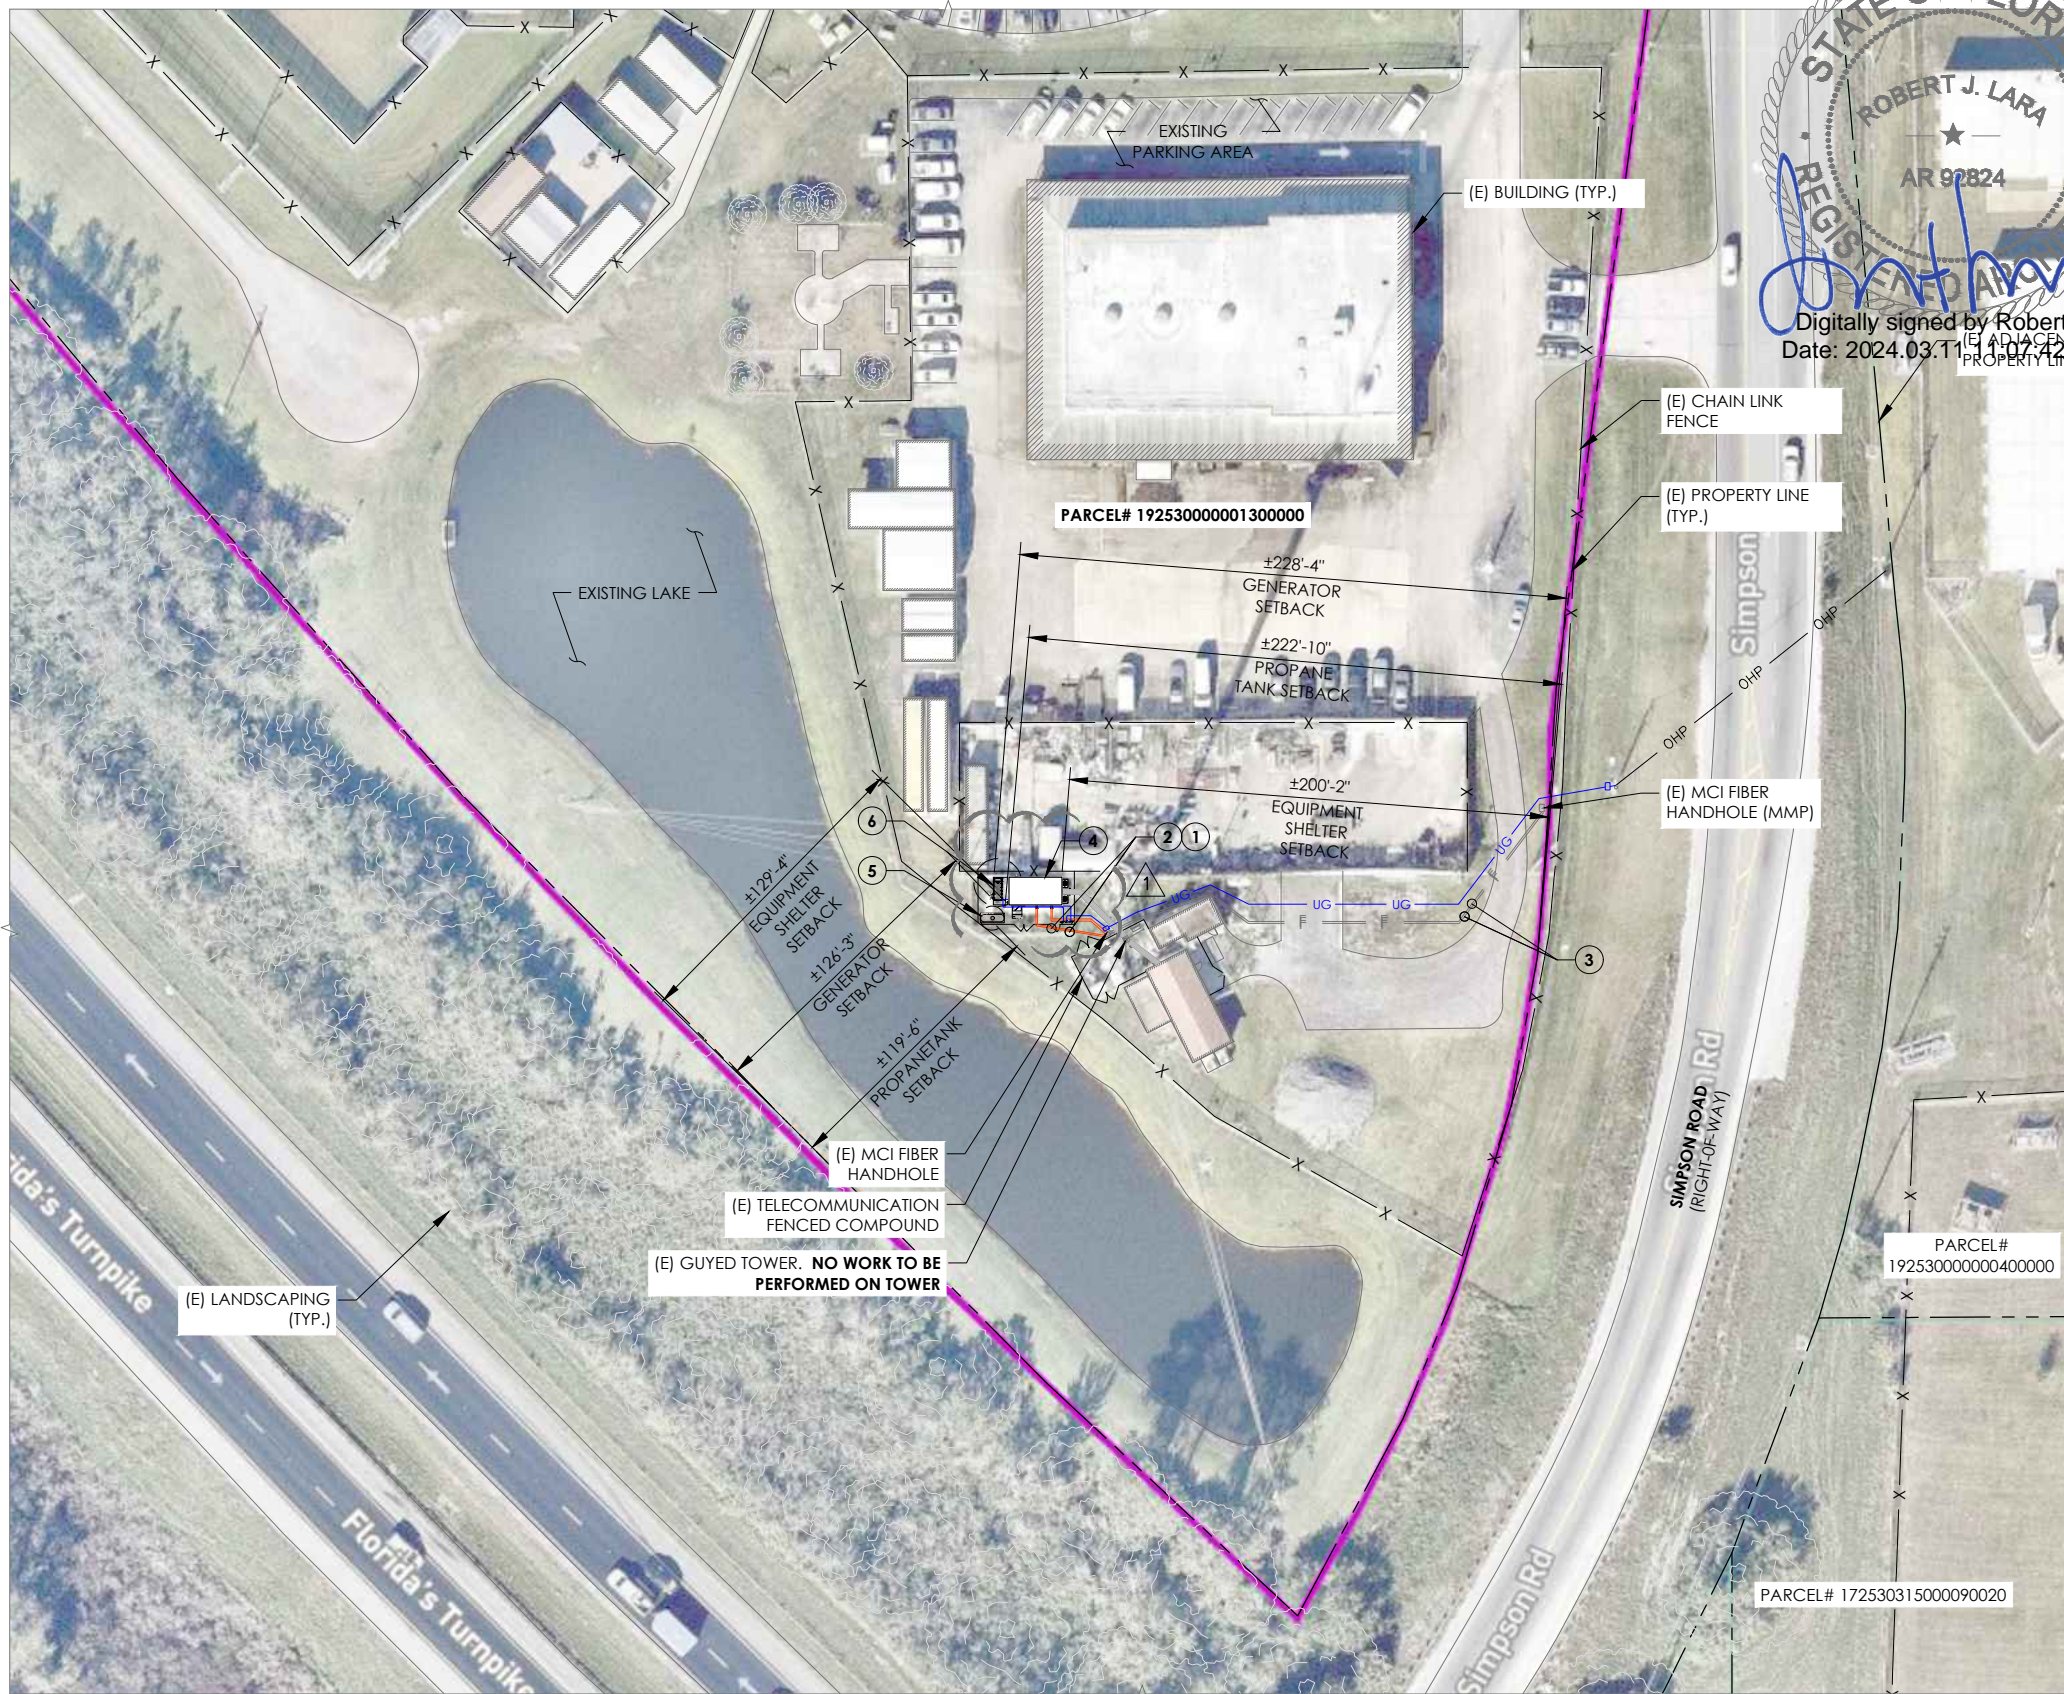

STATE OF FLORIDA
 REGISTERED PROFESSIONAL ENGINEER
 ROBERT J. LARA
 AR 92824
 Digitally signed by Robert Lara
 Date: 2024.03.11 11:07:42 -04'00'

NOTES:


1. SITE GROUNDING SHALL COMPLY WITH VERIZON WIRELESS GROUNDING STANDARDS, LATEST EDITION, AND COMPLY WITH VERIZON WIRELESS GROUNDING CHECKLIST, LATEST VERSION. WHEN NATIONAL AND LOCAL GROUNDING CODES ARE MORE STRINGENT THEY SHALL GOVERN.
2. ANY DAMAGE TO ADJACENT PROPERTIES SHALL BE CORRECTED AT THE CONTRACTOR'S EXPENSE.
3. CONTRACTOR SHALL VERIFY LOCATION OF ALL EXISTING UTILITIES WITHIN CONSTRUCTION LIMITS PRIOR TO CONSTRUCTION.
4. THE CONTRACTOR IS RESPONSIBLE FOR MAINTAINING POSITIVE DRAINAGE ON THE SITE AT ALL TIMES. SILT AND EROSION CONTROL SHALL BE MAINTAINED ON THE DOWNSTREAM SIDE OF THE SITE AT ALL TIMES. ANY DAMAGE TO ADJACENT PROPERTIES SHALL BE CORRECTED AT THE CONTRACTOR'S EXPENSE.
5. CLEARING OF TREES AND VEGETATION ON THE SITE SHOULD BE HELD TO A MINIMUM. ONLY THE TREES NECESSARY FOR CONSTRUCTION OF THE FACILITIES SHALL BE REMOVED. ANY DAMAGE TO PROPERTY OUTSIDE THE LEASE PROPERTY SHALL BE REPAIRED BY THE CONTRACTOR.
6. ALL SUITABLE BORROW MATERIAL FOR BACK FILL OF THE SITE SHALL BE INCLUDED IN THE BID. EXCESS TOPSOIL AND UNSUITABLE MATERIAL SHALL BE DISPOSED OF OFF SITE AT LOCATIONS APPROVED BY GOVERNING AGENCIES PRIOR TO DISPOSAL.
7. SEEDING AND MULCHING OF THE SITE SHALL BE ACCOMPLISHED AS SOON AS POSSIBLE AFTER COMPLETION OF THE SITE DEVELOPMENT. THE CONTRACTOR IS RESPONSIBLE FOR PROVIDING AND MAINTAINING AN ADEQUATE COVER OF VEGETATION OVER THE SITE FOR A ONE YEAR PERIOD.
8. THE CONTRACTOR SHALL VISIT THE SITE BEFORE BIDDING ON THE WORK CONTAINED IN THIS DESIGN PACKAGE.

KEY NOTES:

- ① (P) (2) 2" UNDERGROUND PVC CONDUIT WITH 1-1/4" INNERDUCT AND MULE TAPE.
- ② CROWN CASTLE TO BRING FIBER FROM RIGHT-OF-WAY UTILIZING VERIZON (P) 1-1/4" INNERDUCT AND MULE TAPE TO DEMARC.
- ③ (P) 1-1/4" INNERDUCT AND MULE TAPE WITHIN EACH EXISTING CONDUIT FROM MMP TO EXISTING FIBER HANDHOLE OUTSIDE THE FENCED COMPOUND ROUTED WITHIN EXISTING UTILITY EASEMENT.
- ④ (P) VERIZON WIRELESS 11'-6" x22'-0" PREFABRICATED EQUIPMENT SHELTER WITH PATIO GENERATOR FRAMING SHALL BE DESIGNED AND MANUFACTURED TO SUPPORT THE PROPOSED FLOOR MOUNTED EQUIPMENT AND THE WALL-MOUNTED HVAC UNITS ANCHORED TO (E) CONCRETE PAD AND (P) 8'-6" x11'-6" CONCRETE PAD EXTENSION. REFER TO SHEETS A504 & S301 FOR DETAILS.
- ⑤ (P) VERIZON 500 GALLON LP TANK W/ SHUT OFF VALVE ON (P) 4'-0"x10'-0" CONCRETE PAD. REFER TO SHEET A503 FOR TANK & 4/S302 FOR DETAILS.
- ⑥ (P) VERIZON 60kW LP GENERATOR ANCHORED TO (P) CONCRETE PAD EXTENSION. REFER TO SHEET A502 FOR GENERATOR DETAILS AND SHEET S301 FOR CONCRETE PAD DETAILS.

FLOOD ZONE NOTE:
 ACCORDING TO FIRM MAP 120189 PANEL 12086C0288 DATED 06/18/2013 THE SUBJECT PROPERTY IS IN FLOOD ZONE "X (SHADED)"

PROPOSED CONDUIT LOCATIONS ARE SHOWN SCHEMATICALLY. CONTRACTOR SHALL FIELD VERIFY LOCATIONS PRIOR TO CONSTRUCTION.

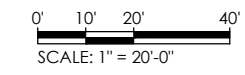

Sunshine 811
 Call 811 or visit sunshine811.com two full business days before digging to have buried facilities located and marked.
 check positive response codes before you dig!

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 THIS DRAWING WAS PREPARED SOLELY FOR THE USE OF VERIZON WIRELESS AND MUST ONLY BE USED BY VERIZON WIRELESS EMPLOYEES, CONTRACTORS, AND VENDORS WHILE PERFORMING THE WORK SHOWN ON THIS DRAWING. ANY OTHER USE OF THIS DRAWING IS FORBIDDEN.

MORRISON HERSHFIELD
Stantec
 Two South University Drive, Suite 245,
 Plantation, FL 33324
 Tel: 954.577.4655
 www.morrisonhershfield.com

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 OSCEOLA COUNTY SIMPSON ROAD
 LOCATION CODE: 5000302137
 350 SIMPSON ROAD
 KISSIMMEE, FL 34744

NO.	DESCRIPTION	DATE
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0	ISSUED FOR PERMIT	05.02.23
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NETWORK COMPLIANCE SUBMITTALS		DATE
100% SUBMISSION		DATE
RE-SUBMISSION (IF REQUIRED)		DATE


PROJECT #:	22048480
CAD DWG FILE #:	
DESIGNED BY:	CT
DRAWN BY:	GO
CHECKED BY:	RL/CT

PROPOSED SITE PLAN
C111

PROPOSED SITE PLAN
 22" x 34" SCALE: 1" = 20'-0"
 11" x 17" SCALE: 1" = 40'-0"

SECTION B-FLOOD INSURANCE RATE MAP (FIRM) INFORMATION

B1. NFIP COMMUNITY NAME & COMMUNITY NUMBER UNINCORPORATED OSCEOLA COUNTY & 120189		B2. COUNTY NAME OSCEOLA		B3. STATE FLORIDA	
B4. MAP/PANEL NUMBER 12097C0090	B5. SUFFIX G	B6. FIRM PANEL EFFECTIVE/REVISED DATE 06/18/2013	B7. FIRM PANEL EFFECTIVE/REVISED DATE 06/18/2013	B8. FIRM FLOOD ZONE (S) X (SHADED)	B9. BASE FLOOD ELEVATION (S) (ZONE X USE BASE FLOOD DEPTH) N/A

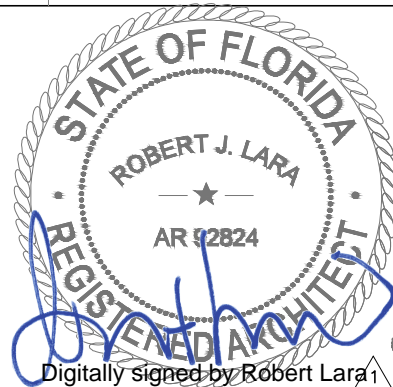

Digitally signed by Robert Lara
Date: 2024.03.11 11:07:49-04'00'

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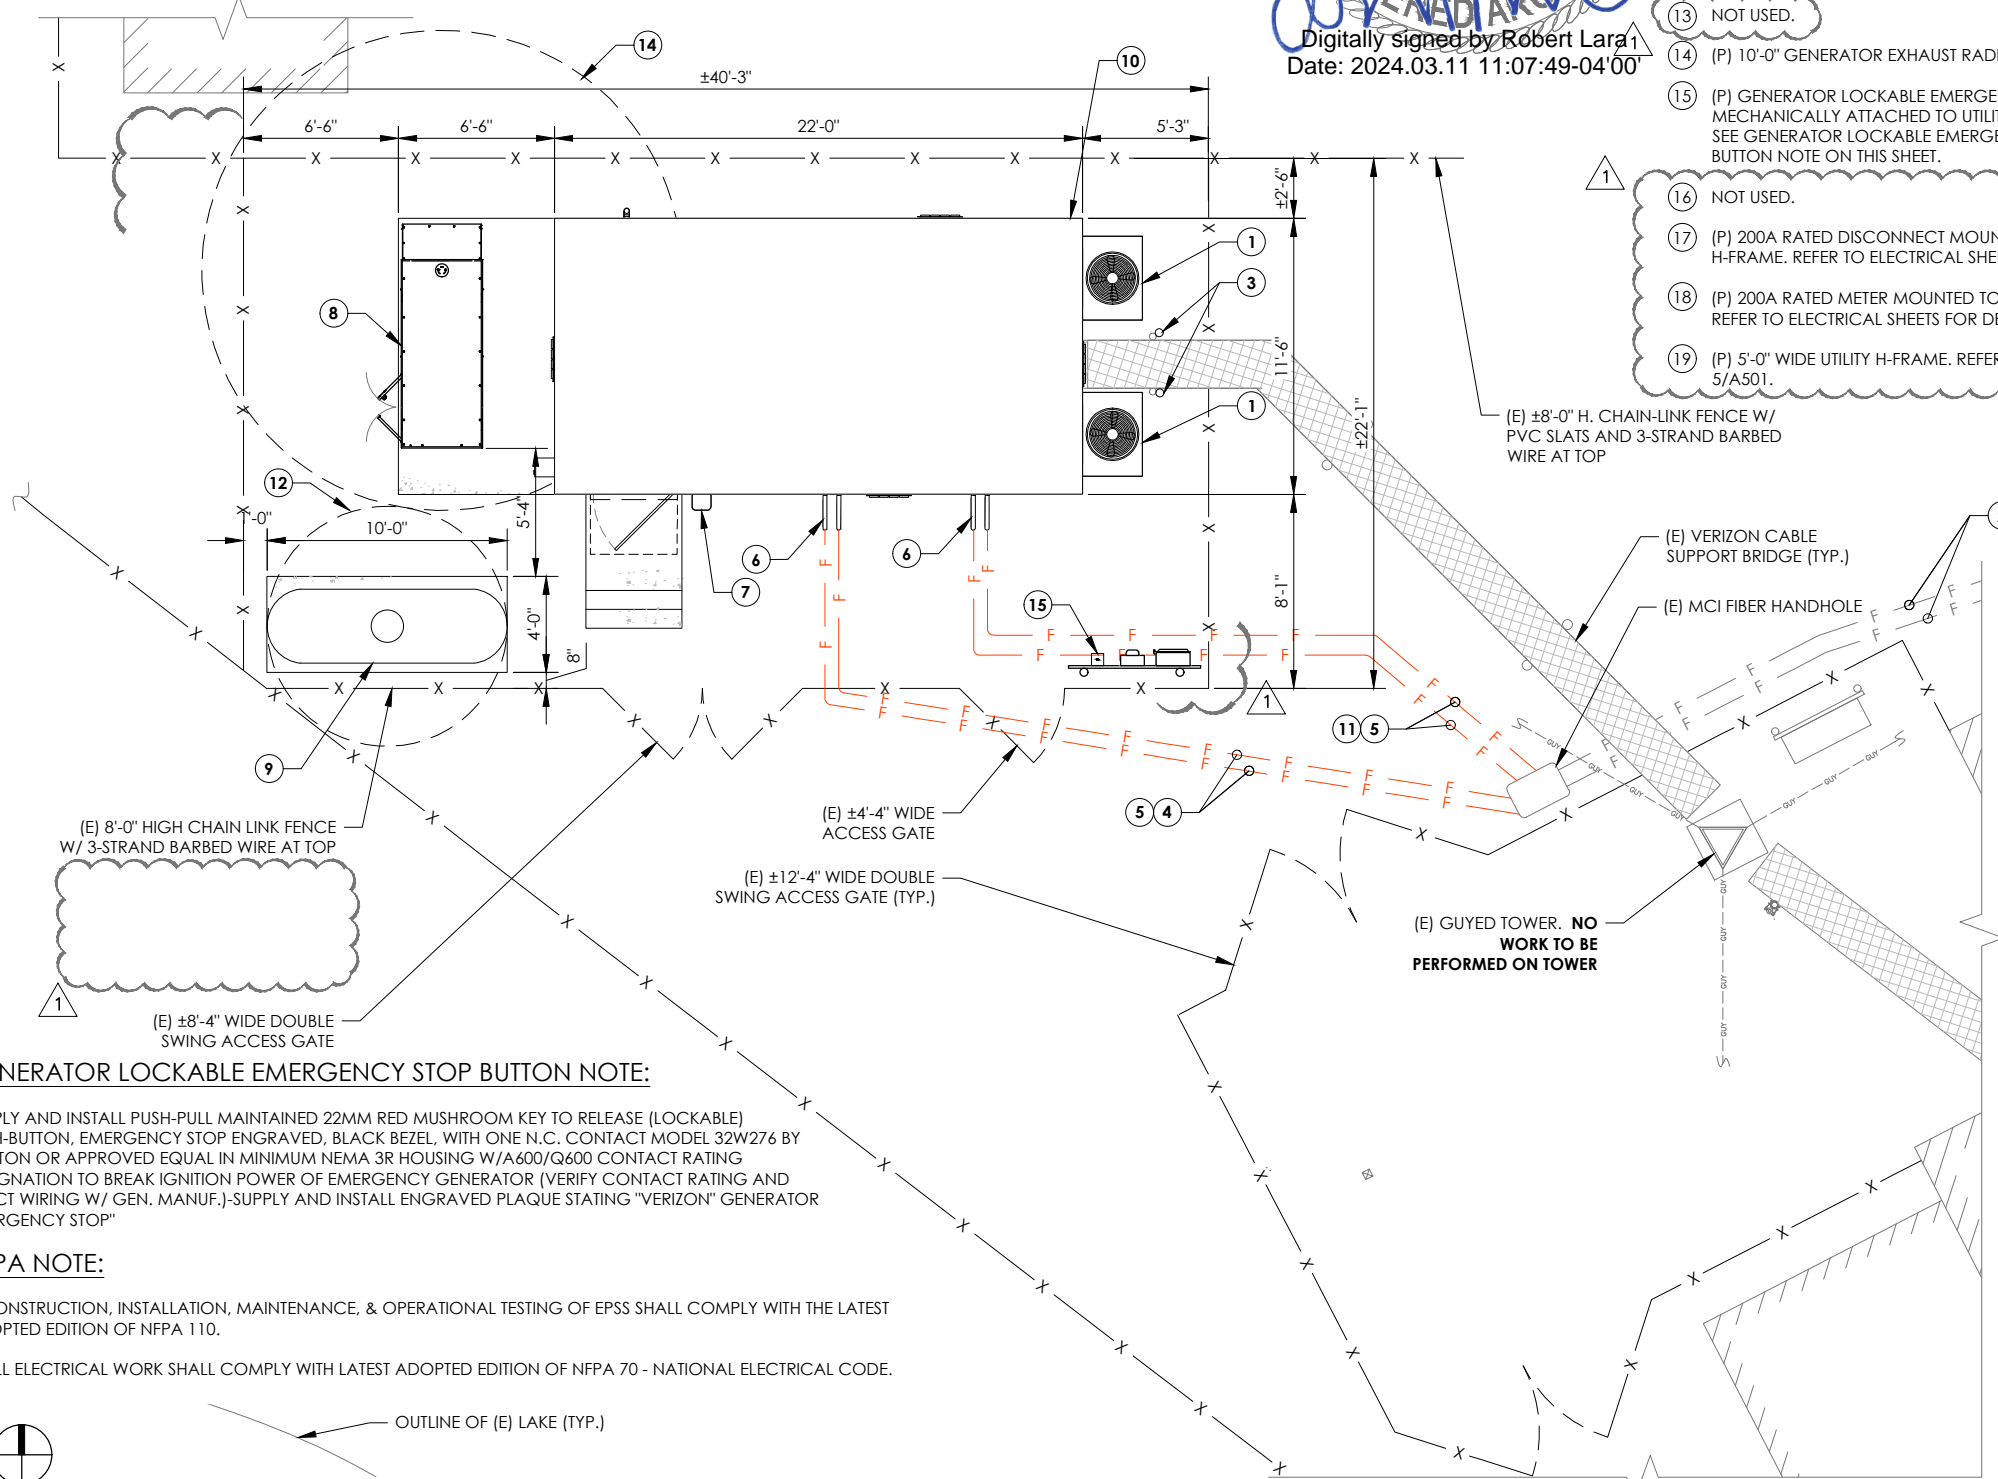
- 11 (E) FIBER PROVIDER TO REROUTE FIBER TO NEW LOCATION BY UTILIZING (P) (2) 2" UNDERGROUND PVC CONDUIT WITH 1-1/4" INNERDUCT AND MULE TAPE FROM EXISTING HANDHOLE OUTSIDE FENCED COMPOUND TO DEMARC. INSIDE SHELTER.
- 12 (P) 5'-0" NO SPARK SOURCE RADIUS.
- 13 NOT USED.
- 14 (P) 10'-0" GENERATOR EXHAUST RADIUS.
- 15 (P) GENERATOR LOCKABLE EMERGENCY STOP BUTTON MECHANICALLY ATTACHED TO UTILITY H-FRAME POST. SEE GENERATOR LOCKABLE EMERGENCY STOP BUTTON NOTE ON THIS SHEET.
- 16 NOT USED.
- 17 (P) 200A RATED DISCONNECT MOUNTED TO (P) H-FRAME. REFER TO ELECTRICAL SHEETS FOR DETAILS.
- 18 (P) 200A RATED METER MOUNTED TO (P) H-FRAME. REFER TO ELECTRICAL SHEETS FOR DETAILS.
- 19 (P) 5'-0" WIDE UTILITY H-FRAME. REFER TO DETAIL 5/A501.

NOTES:

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KEY NOTES:

- 1 (P) HVAC WALL PACK UNIT MOUNTED TO SHELTER WALL (TYP. OF 2). REFER TO MECHANICAL SHEET FOR NOTES AND SPECS.
- 2 (P) 1-1/4" INNERDUCT AND MULE TAPE WITHIN EACH EXISTING CONDUIT FROM MMP TO EXISTING FIBER HANDHOLE OUTSIDE THE FENCED COMPOUND ROUTED WITHIN EXISTING UTILITY EASEMENT.
- 3 (P) VERIZON GPS ANTENNA (TYP. OF 2). REFER TO DETAIL 1/A501.
- 4 CROWN CASTLE TO BRING FIBER FROM EXISTING HANDHOLE OUTSIDE FENCED COMPOUND BY UTILIZING VERIZON (P) 1-1/4" INNERDUCT AND MULE TAPE TO DEMARC. INSIDE SHELTER
- 5 (P) (2) 2" UNDERGROUND PVC CONDUIT WITH 1-1/4" INNERDUCT AND MULE TAPE.
- 6 (P) (2) 2" RIGID CONDUIT FIBER ENTRANCE (TYP.). REFER TO DETAIL 3 ON SHEET A501.
- 7 (P) SHELTER ACCESS DOOR (PART OF THE SHELTER) NEW GASKET SEALS PERIMETER OF DOOR.
- 8 (P) VERIZON 60KW LP GENERATOR ANCHORED TO CONCRETE PAD EXTENSION. REFER TO SHEET A502 FOR GENERATOR DETAILS AND SHEET S302 FOR CONCRETE PAD DETAILS.
- 9 (P) VERIZON 500 GALLON LP TANK W/ SHUT OFF VALVE ON (P) 4'-0"x10'-0" CONCRETE PAD. REFER TO SHEET A503 FOR TANK & 4/S302 FOR DETAILS.
- 10 (P) VERIZON WIRELESS 11'-6"x22'-0" PREFABRICATED EQUIPMENT SHELTER WITH PATIO GENERATOR FRAMING SHALL BE DESIGNED AND MANUFACTURED TO SUPPORT THE PROPOSED FLOOR MOUNTED EQUIPMENT AND THE WALL-MOUNTED HVAC UNITS ANCHORED TO (E) CONCRETE PAD AND (P) 8'-6" x11'-6" EXTENSION. REFER TO SHEETS A504 & S301 FOR DETAILS.



GENERATOR LOCKABLE EMERGENCY STOP BUTTON NOTE:

SUPPLY AND INSTALL PUSH-PULL MAINTAINED 22MM RED MUSHROOM KEY TO RELEASE (LOCKABLE) PUSH-BUTTON, EMERGENCY STOP ENGRAVED, BLACK BEZEL, WITH ONE N.C. CONTACT MODEL 32W276 BY DAYTON OR APPROVED EQUAL IN MINIMUM NEMA 3R HOUSING W/A600/Q600 CONTACT RATING DESIGNATION TO BREAK IGNITION POWER OF EMERGENCY GENERATOR (VERIFY CONTACT RATING AND EXACT WIRING W/ GEN. MANUF.)-SUPPLY AND INSTALL ENGRAVED PLAQUE STATING "VERIZON" GENERATOR EMERGENCY STOP"

NFPA NOTE:

1. CONSTRUCTION, INSTALLATION, MAINTENANCE, & OPERATIONAL TESTING OF EPSS SHALL COMPLY WITH THE LATEST ADOPTED EDITION OF NFPA 110.
2. ALL ELECTRICAL WORK SHALL COMPLY WITH LATEST ADOPTED EDITION OF NFPA 70 - NATIONAL ELECTRICAL CODE.



OUTLINE OF (E) LAKE (TYP.)

1 PROPOSED COMPOUND PLAN

22' x 34" SCALE: 1/4" = 1'-0"
11' x 17" SCALE: 1/8" = 1'-0"

SCALE: 1/4" = 1'-0"



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OSCEOLA COUNTY SIMPSON ROAD
LOCATION CODE: 5000302137
350 SIMPSON ROAD
KISSIMMEE, FL 34744

NO.	DESCRIPTION	DATE
A	ISSUED FOR 90% CD SUBMITTAL	04.04.23
0	ISSUED FOR PERMIT	05.02.23
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PROJECT #	DATE
22048480	

CAD DWG FILE #	DATE


DESIGNED BY	DATE
CT	

DRAWN BY	DATE
GO	

CHECKED BY	DATE
RLCT	

PROPOSED COMPOUND PLAN

C112

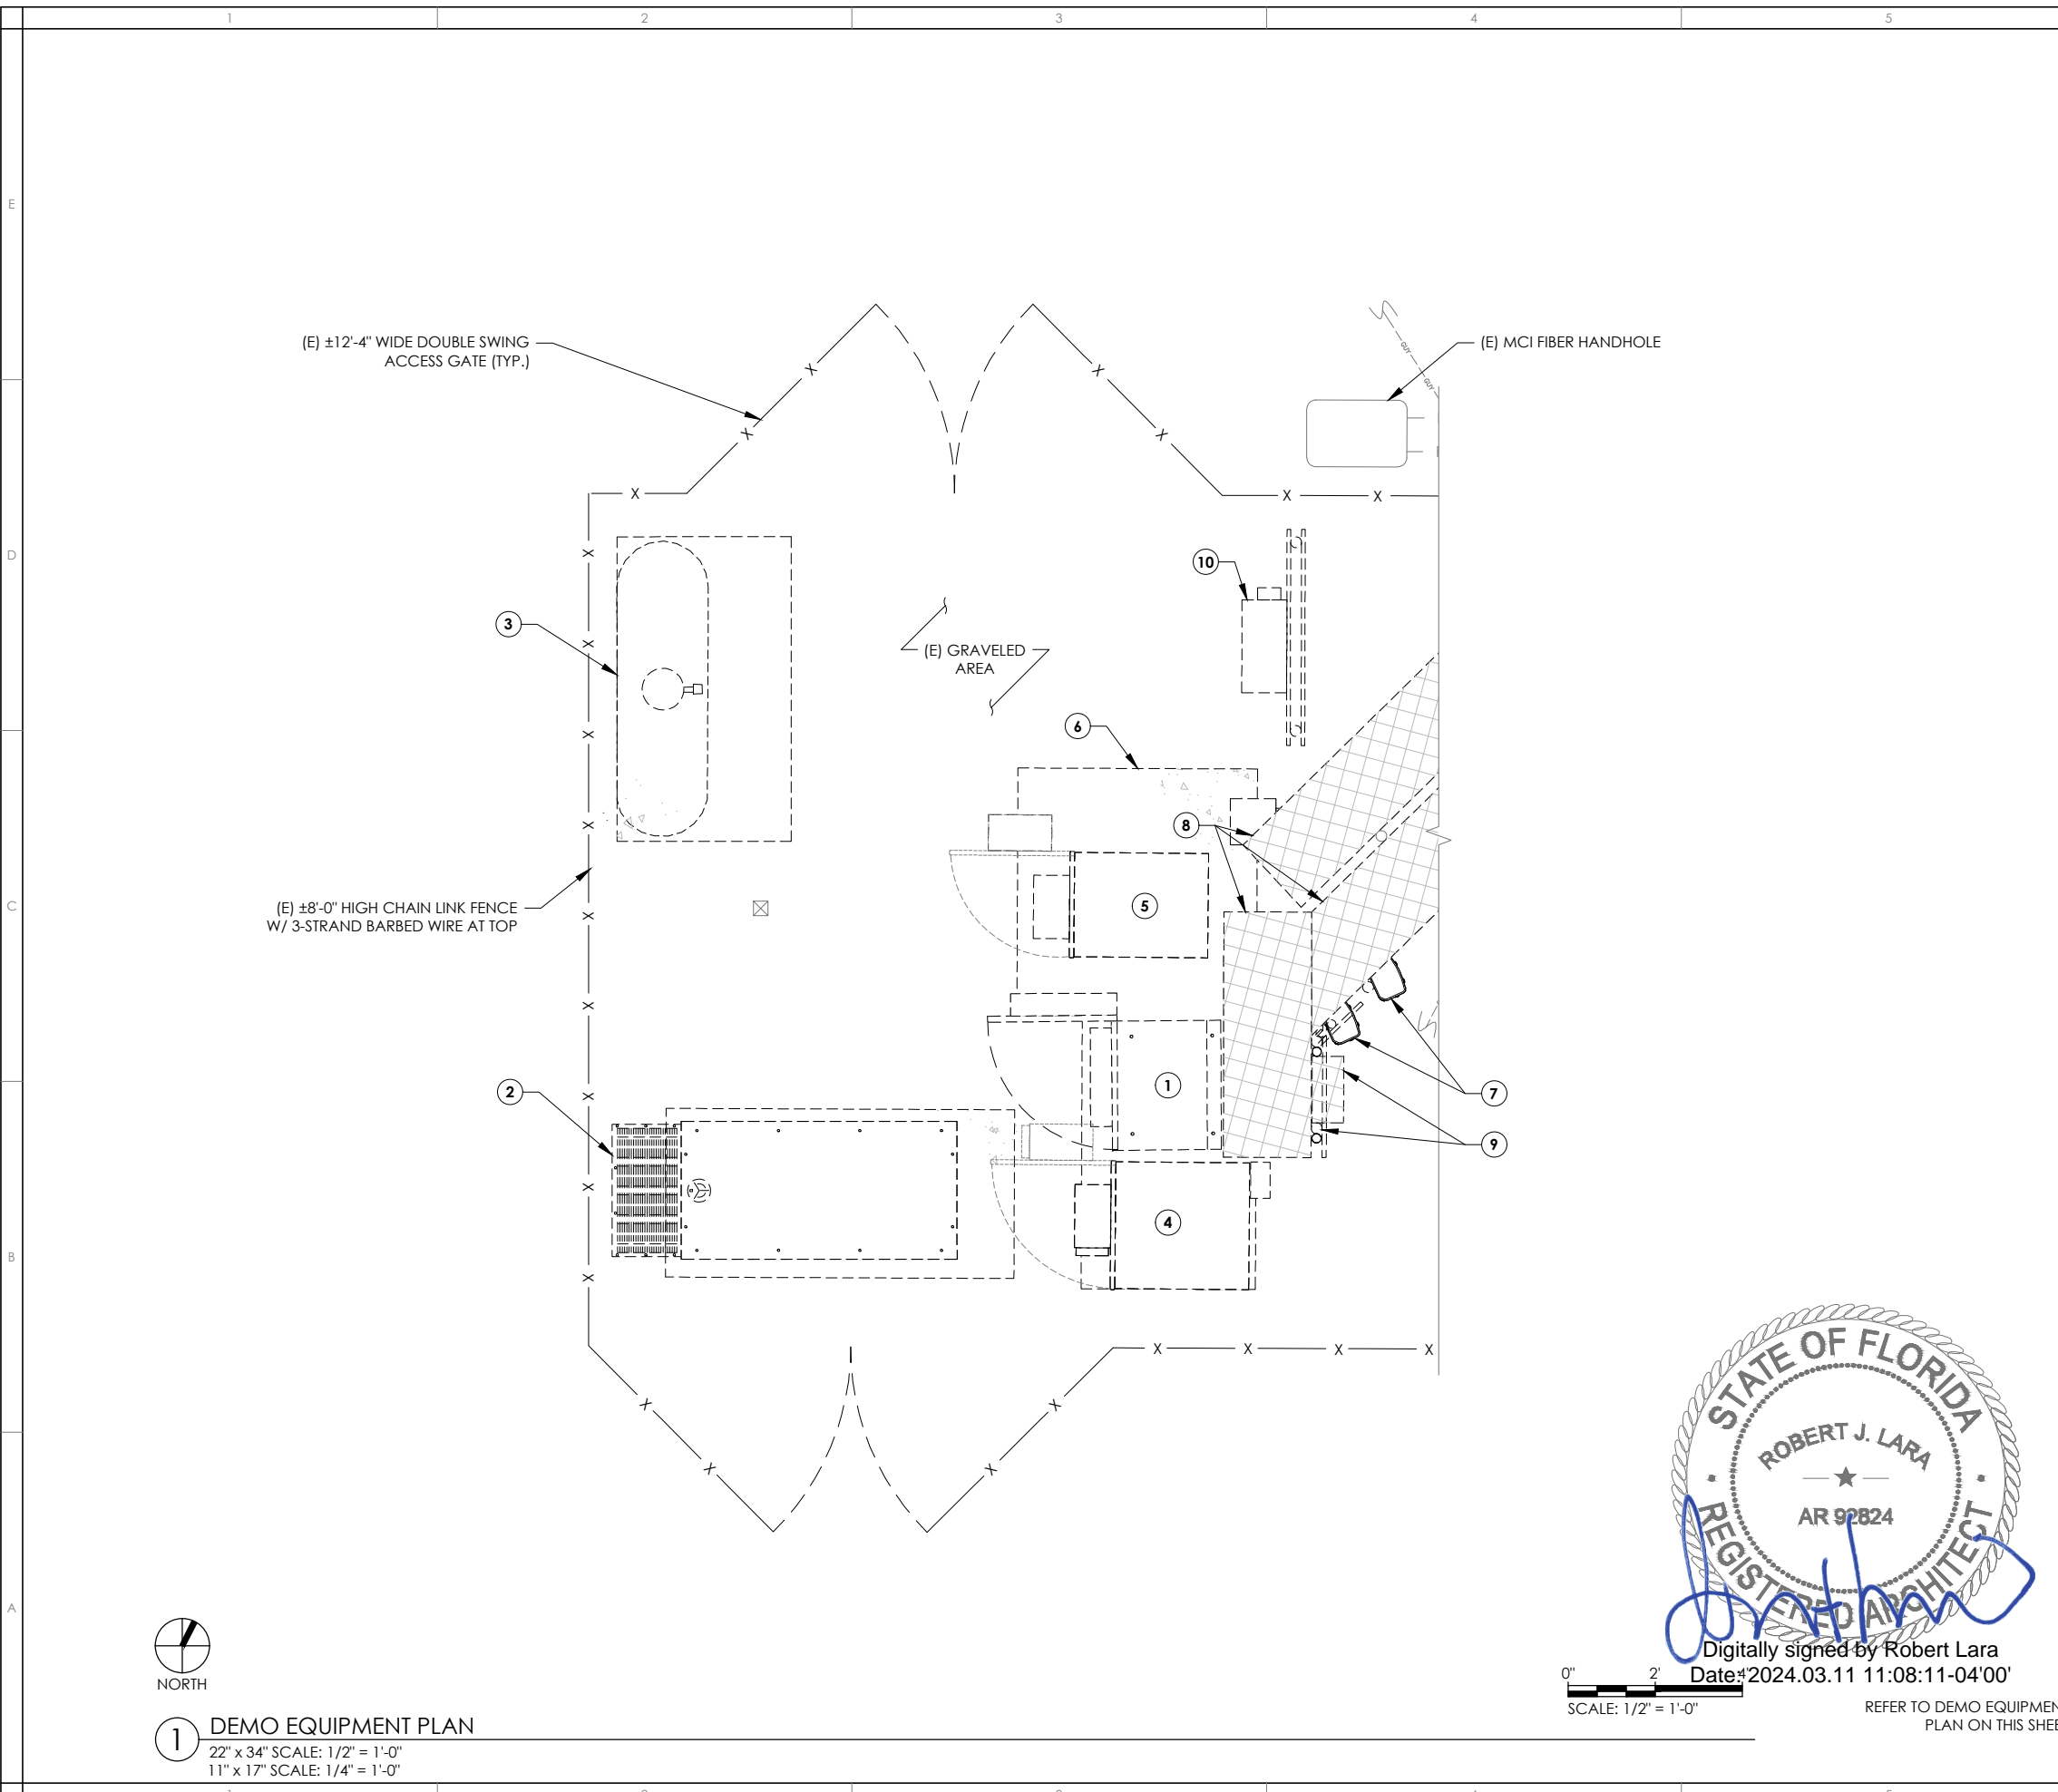


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9. ALL WALL (INTERIOR OR EXTERIOR) OPENINGS CREATED, UNCOVERED OR DISCOVERED DURING HVAC UPGRADE SHALL BE REPAIRED TO EQUAL OR BETTER CONDITION.


KEY NOTES:

- ① (E) VERIZON CDMA CABINET TO BE REMOVED.
- ② (E) VERIZON 48kW LP GENERATOR AND CONCRETE GENERATOR PAD TO BE REMOVED.
- ③ (E) VERIZON 250 GALLON PROPANE TANK AND CONCRETE LP PAD TO BE REMOVED .
- ④ (E) VERIZON BATTERY CABINET TO BE REMOVED.
- ⑤ (E) VERIZON LTE EQUIPMENT CABINET TO BE REMOVED AND EQUIPMENT INSIDE TO BE RELOCATED TO NEW VZW RACKS.
- ⑥ (E) VERIZON CONCRETE EQUIPMENT PAD TO BE REMOVED.
- ⑦ (E) VERIZON OVP TO BE RELOCATED TO NEW RAYCAP RACK.
- ⑧ (E) VERIZON CABLE SUPPORT BRIDGE TO BE REMOVED.
- ⑨ (E) VERIZON METER, DISCONNECT AND SUPPORT POST TO BE REMOVED.
- ⑩ (E) 200A ILC AND UTILITY H-FRAME TO BE REMOVED.

KEY PLAN (NOT TO SCALE)

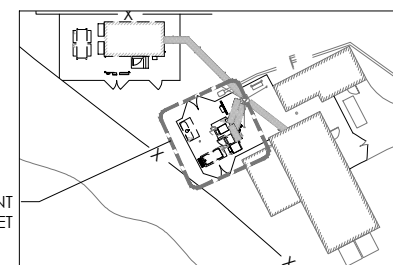


1 DEMO EQUIPMENT PLAN
 22' x 34" SCALE: 1/2" = 1'-0"
 11' x 17" SCALE: 1/4" = 1'-0"

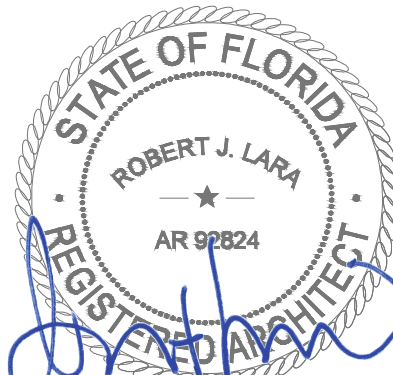

Digitally signed by Robert Lara
 Date: 2024.03.11 11:08:11-04'00'

SCALE: 1/2" = 1'-0"

REFER TO DEMO EQUIPMENT PLAN ON THIS SHEET

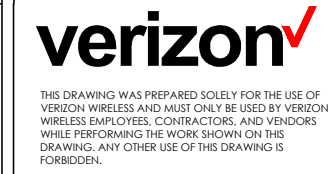


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PROJECT #:	22048800
CAD DWG FILE #:	
DESIGNED BY:	CT
DRAWN BY:	GO
CHECKED BY:	RL/CT

DEMO EQUIPMENT PLAN
AD101






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KEY NOTES:

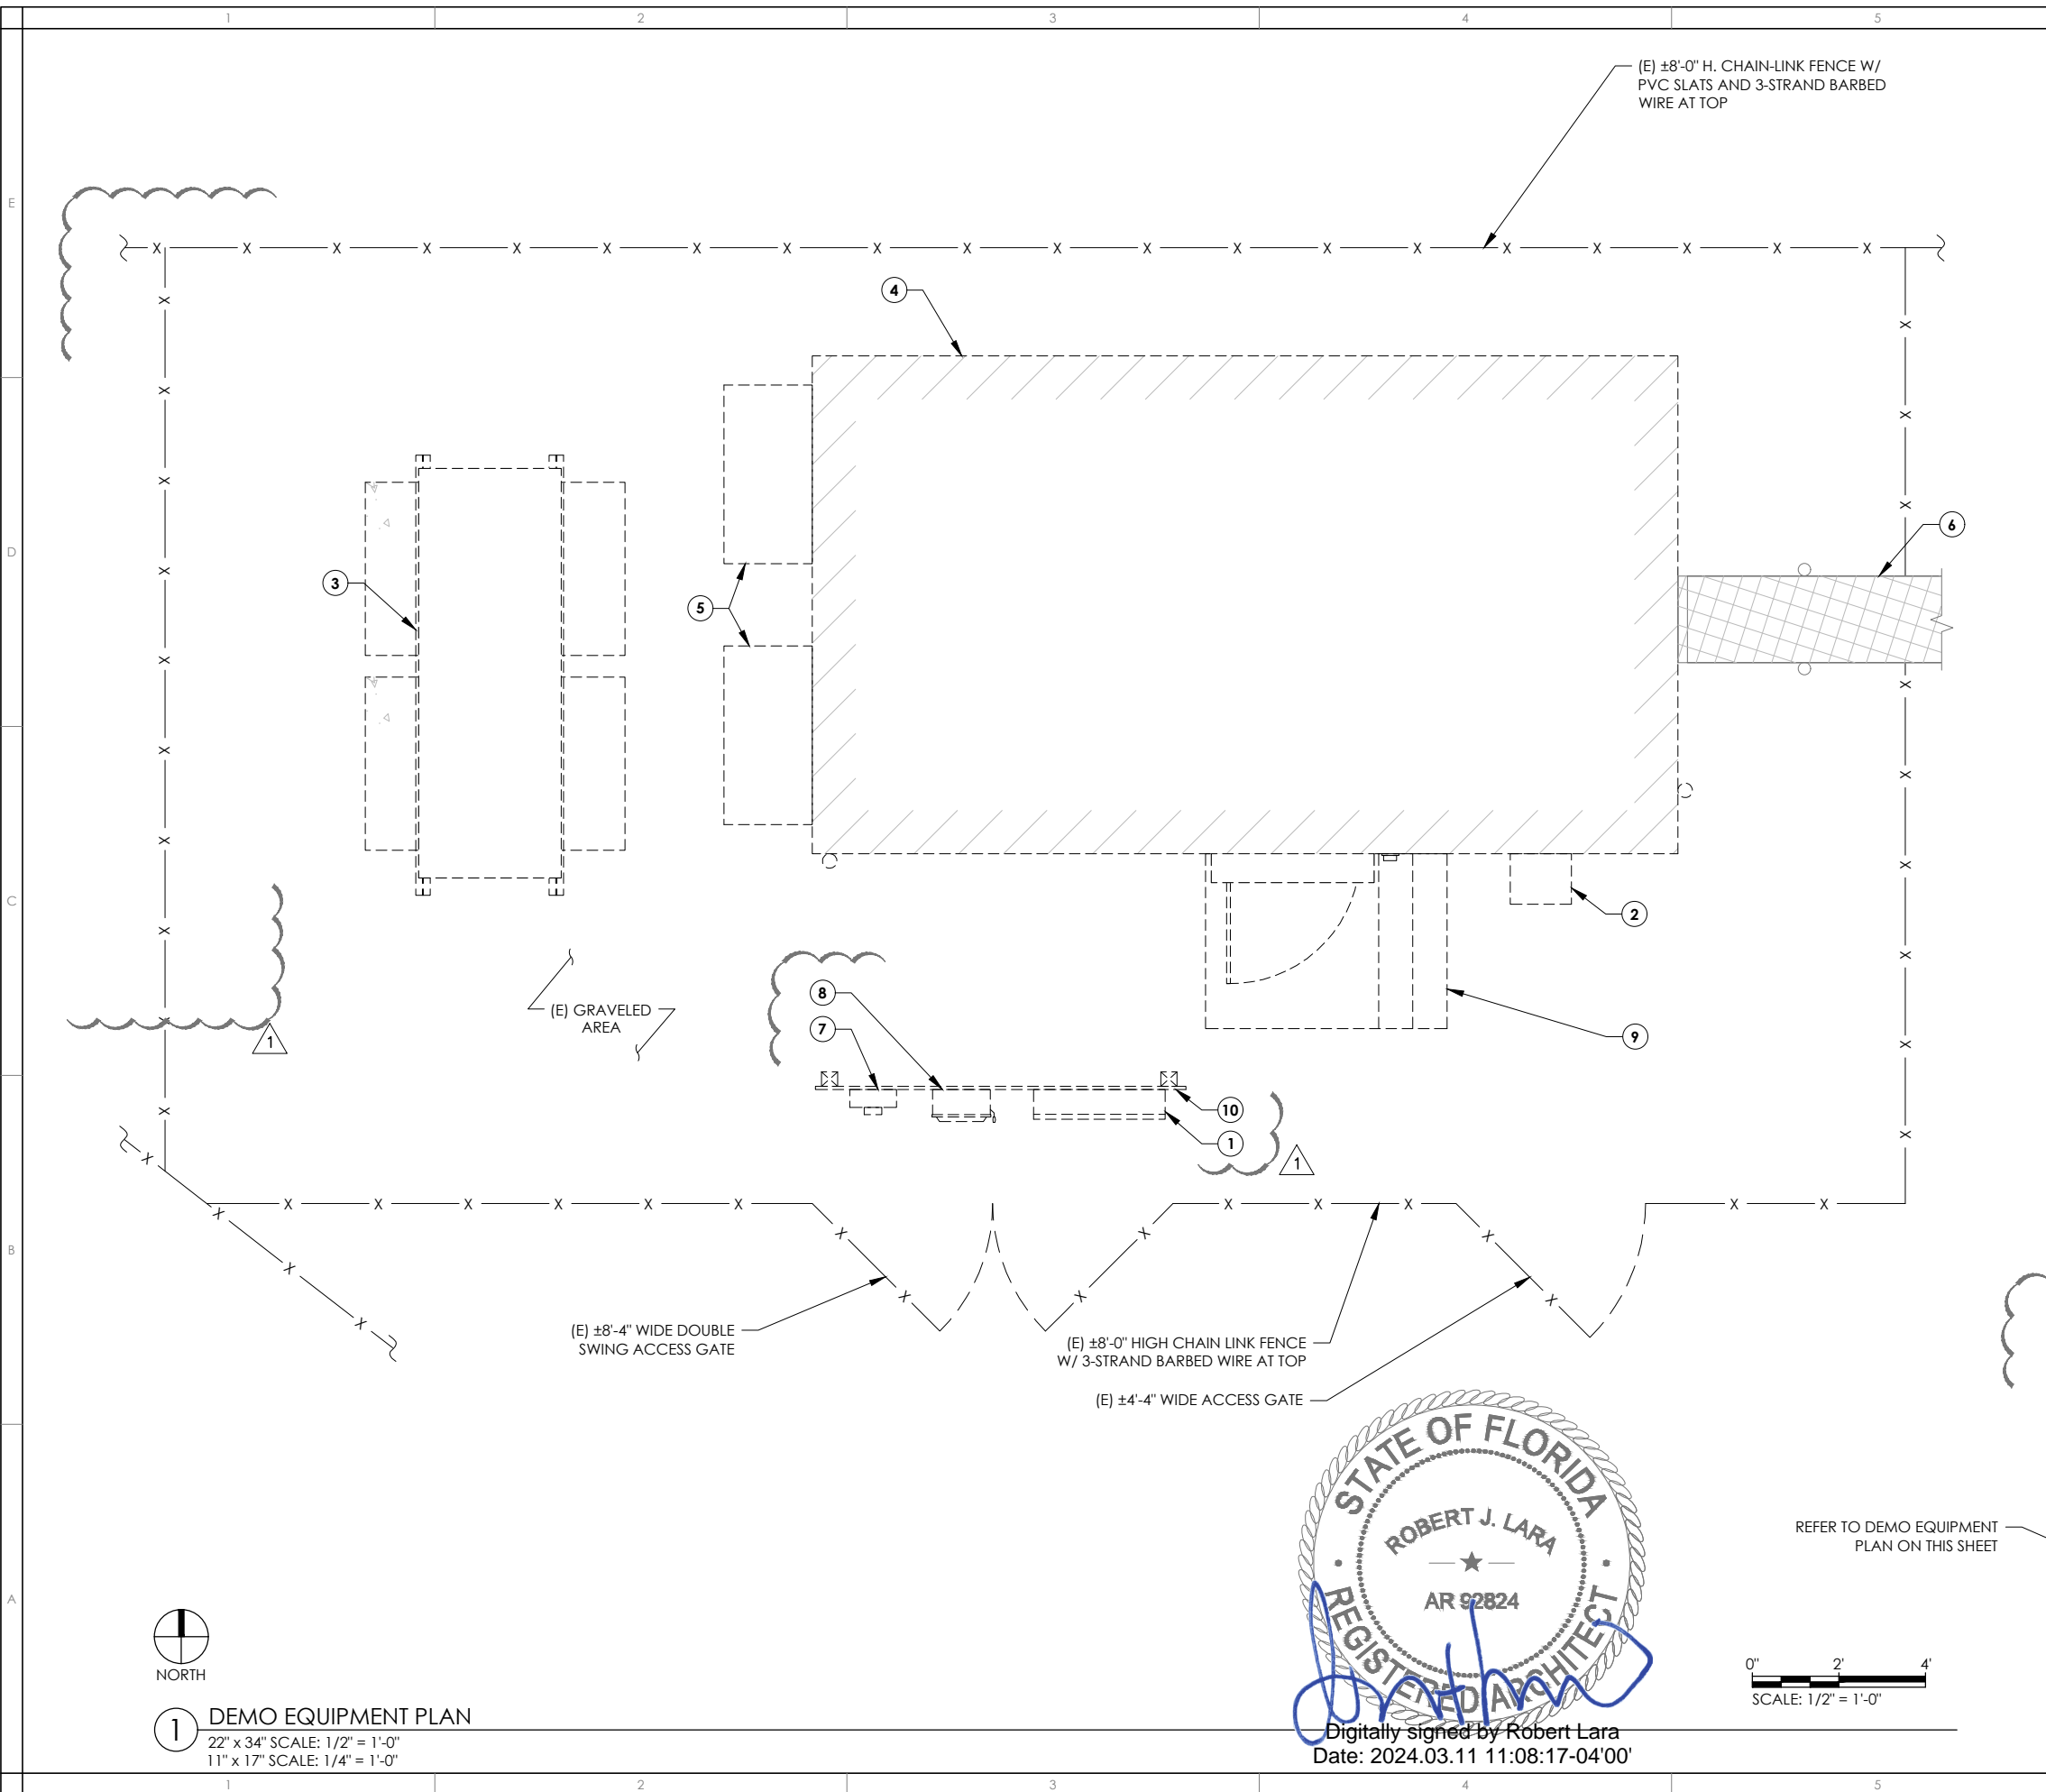- ① (E) TELCO CABINET TO BE REMOVED.
- ② (E) ATS TO BE REMOVED.
- ③ (E) DIESEL GENERATOR AND CONCRETE PADS W/ I-BEAMS TO BE REMOVED.
- ④ (E) SHELTER TO BE REMOVED & REPLACED AND SHELTER FOUNDATION TO REMAIN.
- ⑤ (E) A/C UNITS TO BE REMOVED.
- ⑥ (E) ABANDONED CABLE SUPPORT BRIDGE TO BE UTILIZED BY VERIZON.
- ⑦ (E) ABANDONED 200A METER TO BE REMOVED.
- ⑧ (E) ABANDONED 200A DISC. TO BE REMOVED.
- ⑨ (E) CONCRETE STOOP TO BE REMOVED TO ALLOW INSTALLATION AND ACCESS TO (P) EQUIPMENT SHELTER.
- ⑩ (E) ABANDONED UTILITY H-FRAME TO BE REMOVED.


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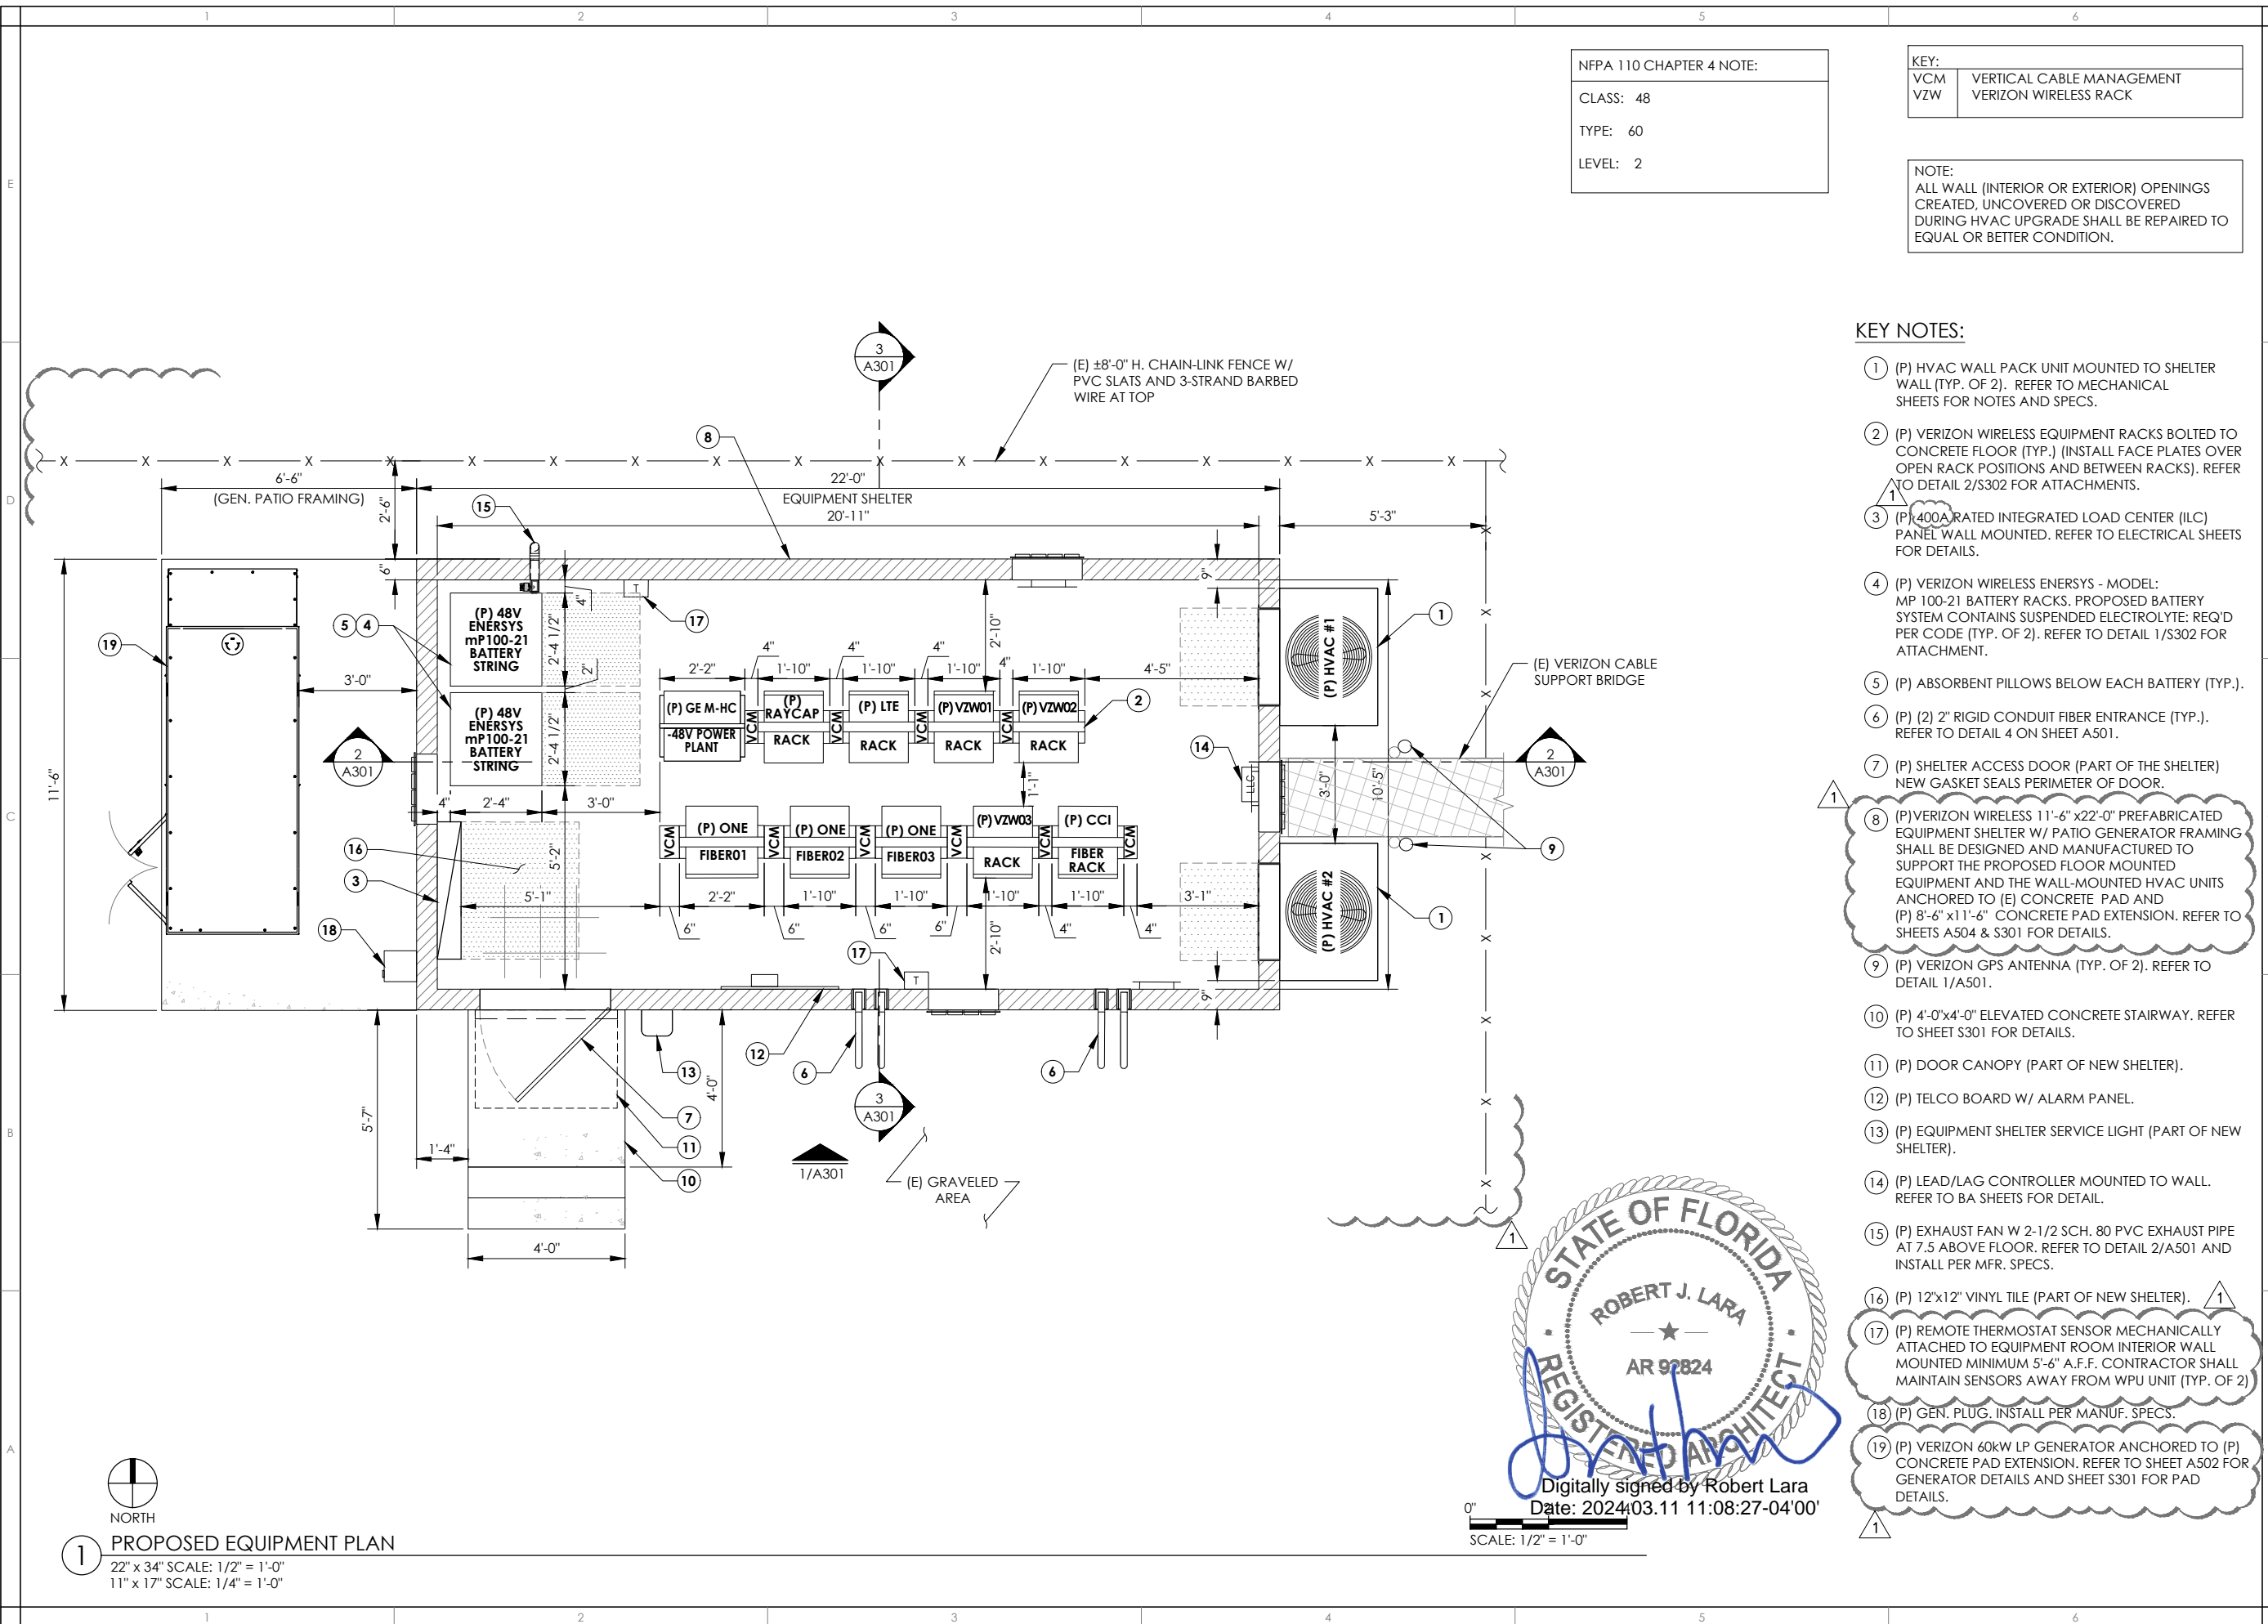
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CAD DWG FILE #:	
DESIGNED BY:	CT
DRAWN BY:	GO
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DEMO EQUIPMENT PLAN

AD102

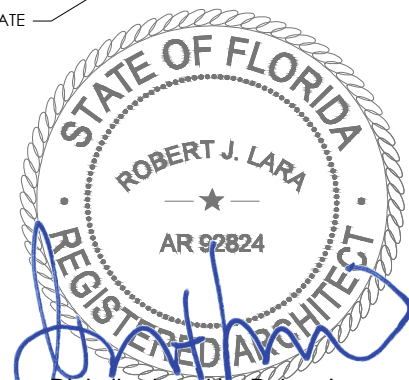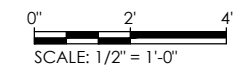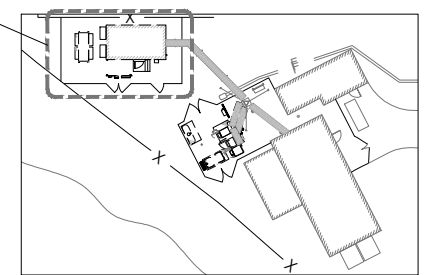


NFPA 110 CHAPTER 4 NOTE:
 CLASS: 48
 TYPE: 60
 LEVEL: 2

KEY:
 VCM VERTICAL CABLE MANAGEMENT
 VZW VERIZON WIRELESS RACK

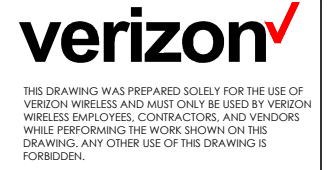NOTE:
 ALL WALL (INTERIOR OR EXTERIOR) OPENINGS CREATED, UNCOVERED OR DISCOVERED DURING HVAC UPGRADE SHALL BE REPAIRED TO EQUAL OR BETTER CONDITION.

KEY NOTES:

- ① (P) HVAC WALL PACK UNIT MOUNTED TO SHELTER WALL (TYP. OF 2). REFER TO MECHANICAL SHEETS FOR NOTES AND SPECS.
- ② (P) VERIZON WIRELESS EQUIPMENT RACKS BOLTED TO CONCRETE FLOOR (TYP.) (INSTALL FACE PLATES OVER OPEN RACK POSITIONS AND BETWEEN RACKS). REFER TO DETAIL 2/S302 FOR ATTACHMENTS.
- ③ (P) 400A RATED INTEGRATED LOAD CENTER (ILC) PANEL WALL MOUNTED. REFER TO ELECTRICAL SHEETS FOR DETAILS.
- ④ (P) VERIZON WIRELESS ENERSYS - MODEL: MP 100-21 BATTERY RACKS. PROPOSED BATTERY SYSTEM CONTAINS SUSPENDED ELECTROLYTE: REQ'D PER CODE (TYP. OF 2). REFER TO DETAIL 1/S302 FOR ATTACHMENT.
- ⑤ (P) ABSORBENT PILLOWS BELOW EACH BATTERY (TYP.).
- ⑥ (P) (2) 2" RIGID CONDUIT FIBER ENTRANCE (TYP.). REFER TO DETAIL 4 ON SHEET A501.
- ⑦ (P) SHELTER ACCESS DOOR (PART OF THE SHELTER) NEW GASKET SEALS PERIMETER OF DOOR.
- ⑧ (P) VERIZON WIRELESS 11'-6" x 22'-0" PREFABRICATED EQUIPMENT SHELTER W/ PATIO GENERATOR FRAMING SHALL BE DESIGNED AND MANUFACTURED TO SUPPORT THE PROPOSED FLOOR MOUNTED EQUIPMENT AND THE WALL-MOUNTED HVAC UNITS ANCHORED TO (E) CONCRETE PAD AND (P) 8'-6" x 11'-6" CONCRETE PAD EXTENSION. REFER TO SHEETS A504 & S301 FOR DETAILS.
- ⑨ (P) VERIZON GPS ANTENNA (TYP. OF 2). REFER TO DETAIL 1/A501.
- ⑩ (P) 4'-0" x 4'-0" ELEVATED CONCRETE STAIRWAY. REFER TO SHEET S301 FOR DETAILS.
- ⑪ (P) DOOR CANOPY (PART OF NEW SHELTER).
- ⑫ (P) TELCO BOARD W/ ALARM PANEL.
- ⑬ (P) EQUIPMENT SHELTER SERVICE LIGHT (PART OF NEW SHELTER).
- ⑭ (P) LEAD/LAG CONTROLLER MOUNTED TO WALL. REFER TO BA SHEETS FOR DETAIL.
- ⑮ (P) EXHAUST FAN W 2-1/2 SCH. 80 PVC EXHAUST PIPE AT 7.5 ABOVE FLOOR. REFER TO DETAIL 2/A501 AND INSTALL PER MFR. SPECS.
- ⑯ (P) 12"x12" VINYL TILE (PART OF NEW SHELTER).
- ⑰ (P) REMOTE THERMOSTAT SENSOR MECHANICALLY ATTACHED TO EQUIPMENT ROOM INTERIOR WALL MOUNTED MINIMUM 5'-6" A.F.F. CONTRACTOR SHALL MAINTAIN SENSORS AWAY FROM WPU UNIT (TYP. OF 2)
- ⑱ (P) GEN. PLUG. INSTALL PER MANUF. SPECS.
- ⑲ (P) VERIZON 60kW LP GENERATOR ANCHORED TO (P) CONCRETE PAD EXTENSION. REFER TO SHEET A502 FOR GENERATOR DETAILS AND SHEET S301 FOR PAD DETAILS.

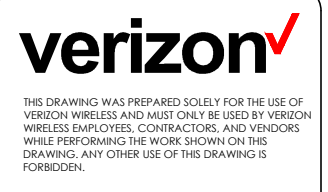

OSCEOLA COUNTY SIMPSON ROAD
 LOCATION CODE: 5000302137
 350 SIMPSON ROAD
 KISSIMMEE, FL 34744


NO.	DESCRIPTION	DATE
A	ISSUED FOR 90% CD SUBMITTAL	04.04.23
0	ISSUED FOR PERMIT	05.02.23
1	RE-DESIGN FOR 22-FOOTER SHELTER WITH PATIO GENERATOR	03.11.24

NETWORK COMPLIANCE SUBMITTALS	DATE
100% SUBMISSION	DATE
RE-SUBMISSION (IF REQUIRED)	DATE

PROJECT #:	22048480
CAD DWG FILE #:	
DESIGNED BY:	CT
DRAWN BY:	GO
CHECKED BY:	RL/CT

PROPOSED FLOOR PLAN

A101

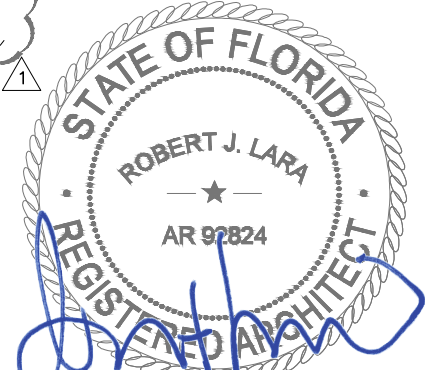

Digitally signed by Robert Lara
 Date: 2024.03.11 11:08:27-04'00'

SCALE: 1/2" = 1'-0"

1 PROPOSED EQUIPMENT PLAN
 22" x 34" SCALE: 1/2" = 1'-0"
 11" x 17" SCALE: 1/4" = 1'-0"